PLUMBING SPECIFICATIONS

GENERAL

- A. ALL WORK CONFORM TO THE REQUIREMENTS OF ALL CODES, ORDINANCES AND STANDARDS OF THE LOCAL JURISDICTION. IN CASE OF A CONFLICT BETWEEN DRAWINGS OR SPECIFICATIONS AND THE REQUIREMENTS OF THE LOCAL JURISDICTION, THE MORE STRINGENT REQUIREMENTS SHALL APPLY.
- B. ALL WORK SHALL BE GUARANTEED AGAINST DEFECTS, LEAKS LACK OF PROPER SYSTEM PERFORMANCE OR NON-OPERATION FOR A PERIOD OF ONE YEAR AFTER DATE OF ACCEPTANCE.
- C. ALL WORK SHALL BE COORDINATED WITH ALL TRADES. PRIOR TO INSTALLATION.
- D. IN GENERAL, DRAWINGS FOR THE WORK ARE DIAGRAMMATIC AND SHOW THE LOCATION, TYPE AND SIZE OF PIPING, EQUIPMENT, AND ACCESSORY EQUIPMENT. THE CONTRACTOR SHALL FURNISH ALL ITEMS NECESSARY FOR THE PROPER INSTALLATION AND OPERATION OF THE WORK, WHETHER CALLED FOR OR NOT. THE CONTRACTOR SHALL VERIFY ALL NECESSARY DIMENSIONS BEFORE INSTALLING ANY OF THE WORK AND SHALL CHECK HIS LAYOUTS TO ALLOW CLEARANCE REQUIRED FOR OTHER WORK. THE SCOPE OF WORK CONSISTS GENERALLY OF PROVIDING AND INSTALLING COMPLETE PLUMBING AND GAS SYSTEMS AND FINAL TESTING OF ALL SYSTEMS AND EQUIPMENT AS REQUIRED.

PRODUCTS

- A. PLUMBING FIXTURES: ALL FIXTURES SHALL BE SELECTED BY OWNER. PROVIDE ALL FIXTURES WITH TRIM, CARRIER SUPPLIES, AND TRAPS AS REQUIRED FOR COMPLETE INSTALLATION.
- B. PIPING AND FITTING:
- . DOMESTIC WATER:

ABOVE GRADE SHALL BE "L" HARD DRAWN COPPER TUBING WITH 125 PSI WROUGHT COPPER SWEAT FITTINGS, AND ALL JOINT SOLDERED WITH 95% OR SILVER SOLDER. BELOW GRADE SHALL BE TYPE "K" SOFT DRAWN COPPER TUBING WITH 125 PSI WROUGHT COPPER SWEAT FITTINGS SOLDERED WITH SILVER SOLDER.

2. SOIL, WASTE AND VENT:

ABOVE GRADE SHALL BE: SERVICE WEIGHT CAST IRON BELL AND SPIGOT. SCHEDULE 40 GALVANIZED STEEL PIPE WITH SWEAT. CAST IRON DRAINAGE PATTERN FITTINGS. CAST IRON NO—HUB PIPING AND FITTINGS. DWV COPPER TUBING AND COPPER DRAINAGE PATTERN FITTINGS. SCHEDULE 40 PVC PLASTIC PIPE AND PVC—DWV FITTING (SHALL NOT BE USED IN PLENUM SPACES).

- C. INSULATION:
- DOMESTIC WATER PIPING: COVER ALL WITH ½" FIBERGLASS INSULATION SECURED WITH ALL PURPOSE JACKET. PIPING IN EXTERIOR WALLS AND PLUMBING CHASES SHALL BE COVERED WITH 1" THICK INSULATION.
- 2. STORM WATER PIPING: THE HORIZONTAL SECTION OF THE RAIN LEADERS, RISER TO AND INCLUDING THE INTERIOR PART OF THE ROOF DRAIN SHALL BE COVERED WITH 1" THICK INSULATION.
- D. VALVES:
- 1. DOMESTIC WATER: ALL VALVES SHALL BE SWEATED BRONZE GATE VALVE WITH SCREW-IN BONNET, RISING STEM MINIMUM RATING OF 125 PSI. TWO PIECES BALL VALVES WITH EXTENDED HANDLE MAY BE USED IN LIEU OF THE GATE VALVES.
- 2. GAS VALVES: SHALL BE OF THE APPROVED TYPE PER AGA LABEL AND SHALL BE INSTALLED AS REQUIRED. GAS VALVES SHALL NOT BE LOCATED IN PLENUM SPACES.
- E. HANGER
- SHALL BE ADJUSTABLE CLEVIS HANGERS, PROPERLY SIZED AND SPACED FOR PIPING, INCLUDING INSULATION.

EXECUTION

- A. INSTALL FIXTURES LEVEL, PLUMB AND PARALLEL TO THE WALLS. ALL EXPOSED METAL PARTS SHALL BE CHROME PLATED AND SHOW NO TOOL MARKS. GROUT BETWEEN WALL HUNG FIXTURES AND WALL. PROVIDE ACCESS PANELS TO ALL CONCEALED SUPPLY STOPS, TRAP, PRIMERS AND WALVES
- B. FIXTURE DESIGNATED FOR USE BY PHYSICALLY HANDICAPPED PEOPLE SHALL BE IN ACCORDANCE WITH ANSI A 117.1.
- C. INSTALL DIELECTRIC CONNECTION BETWEEN DISSIMILAR METALS, PIPE TO PIPE, PIPE TO EQUIPMENT, PIPE TO SUPPORT.
- D. FURNISH AND INSTALL JOSAM 75000 SERIES SHOCK ARRESTERS AT THE ENDS OF ALL HOT AND COLD WATER BRANCHES TO FIXTURES. SIZES SHALL BE IN ACCORDANCE WITH PLUMBING AND DRAINAGE INSTITUTE STANDARD P.D.1.

PLUMBING NOTES

- 1. ALL WORK SHALL BE DONE IN ACCORDANCE WITH THE STATE BUILDING CODE, LOCAL REQUIREMENTS AND THE PROJECT SPECIFICATIONS.
- 2. ALL WORK SHALL BE COORDINATED WITH ALL OTHER TRADES.
- 3. ALL DRAINAGE PIPING SHALL BE RUN AT A SLOPE OF 1/4" PER FOOT UNLESS SPECIFICALLY SHOWN OTHERWISE ON DRAWINGS.
- 4. CONTRACTOR SHALL VISIT SITE PRIOR TO SUBMISSION OF BID TO BECOME FAMILIAR WITH EXISTING CONDITIONS.
- 5. ALL HOT AND COLD WATER SUPPLY PIPING SHALL BE INSULATED.
- 6. PROVIDE AND INSTALL CLEAN—OUTS IN DRAINAGE PIPING AT EACH CHANGE IN DIRECTION OF PIPING GREATER THAN 45 DEGREES, EVERY 50 FEET, AND AS SHOWN.
- 7. EXPOSED UTILITY SERVICE LINES AND PIPES SHALL BE INSTALLED SO THAT THEY DO NOT OBSTRUCT OR PREVENT CLEANING OF THE FLOORS, WALLS, OR CEILINGS. EXPOSED HORIZONTAL UTILITY SERVICE LINES AND PIPES SHALL NOT BE INSTALLED ON THE FLOOR.
- 8. CONTRACTOR SHALL FIELD SURVEY EXISTING CONDITIONS AND PLUMBING SERVICE LOCATIONS PRIOR TO BID AND/OR START WORK ON THIS JOB.


PLUMBING NOTES

- 1. ALL WORK SHALL BE DONE IN ACCORDANCE WITH THE STATE BUILDING CODE, LOCAL REQUIREMENTS AND THE PROJECT SPECIFICATIONS.
- 2. ALL WORK SHALL BE COORDINATED WITH ALL OTHER TRADES.
- 3. CONTRACTOR SHALL FIELD SURVEY EXISTING CONDITIONS AND PLUMBING SERVICE LOCATIONS PRIOR TO BID AND/OR START WORK ON THIS JOB.

EXISTING PLUMBING FIXTURES

WH(E): RUUD MODEL ES50-6-G 208V - 3PH - 6.0KW STOR.TANK= 50 GAL

PLUMBING SYMBOLS AND ABBREVIATIONS

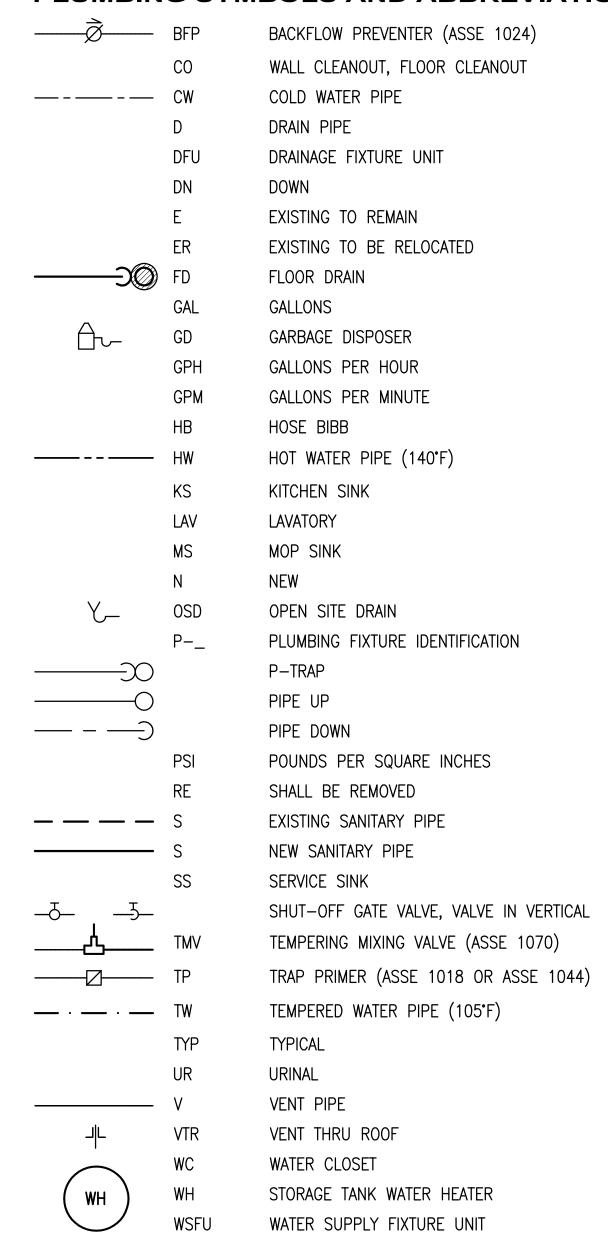

PLUMBING FIXTURE SCHEDULE

MARK	ADA COMPL.	PLUMBING FIXTURE	PLUMBING CONNECTIONS					WSFU	DFU	MANUF.	MODEL	REMARKS	
			TRAP	S	>	HW	TW	CW	WSFU	DFO	WANUF.	MODEL	REMARKS
MWC	YES	MACERATING WATER CLOSET	ı	1"	1-1/2"	ı	ı	1/2"	2.2	3	LIBERTY PUMPS	ASCENTII-ESW	115V. 1/2HP.
LAV	YES	LAVATORY	1-1/2"	1-1/2"	1-1/2"	1	1/2"	1/2"	0.7	1	TBD	TBD	PROVIDED WITH ASSE 1070 TMV.
HS	YES	HAND SINK	1-1/2"	1-1/2"	1-1/2"	1	1/2"	1/2"	0.7	1	TBD	TBD	PROVIDED WITH ASSE 1070 TMV.

NOTE: PLUMBING FIXTURE SPECIFICATIONS TO BE APPROVED BY ARCHITECT OR OWNER.
PLUMBING FIXTURES SHALL BE ADA COMPLIANT.
CONTRACTOR SHALL PROVIDE FIXTURE CARRIER AS REQUIRED.

Design America Engineering, Inc.

MEP CONSULTING ENGINEERS

14080 Red River Dr. Centreville, VA 20121 Voice:571-220-3239 Fax:703-222-3591 e-mail: daeng2000@aol.com

FE Proje	18-012	
ITEM	DESCRIPTION	DATE
	FOR PERMIT	10-26-18

Project/Location:

PROPOSED DOCTOR'S OFFICE 208 Main Street Gaithersburg MD

Owner:

DR. RUPINDER SINGH



PROFESSIONAL CERTIFICATION:

I, RAFAEL COELHO, HEREBY CERTIFY THAT THESE

DOCUMENTS WERE PREPARED OR APPROVED BY ME,

AND THAT I AM A DULY LICENSED PROFESSIONAL

ENGINEER UNDER THE LAWS OF THE STATE OF MARYLAND.

LICENSE # 44287


EXPIRATION DATE: AUGUST 08, 2019

Sheet Title:


PLUMBING NOTES AND SYMBOLS

Sheet Number:

P001

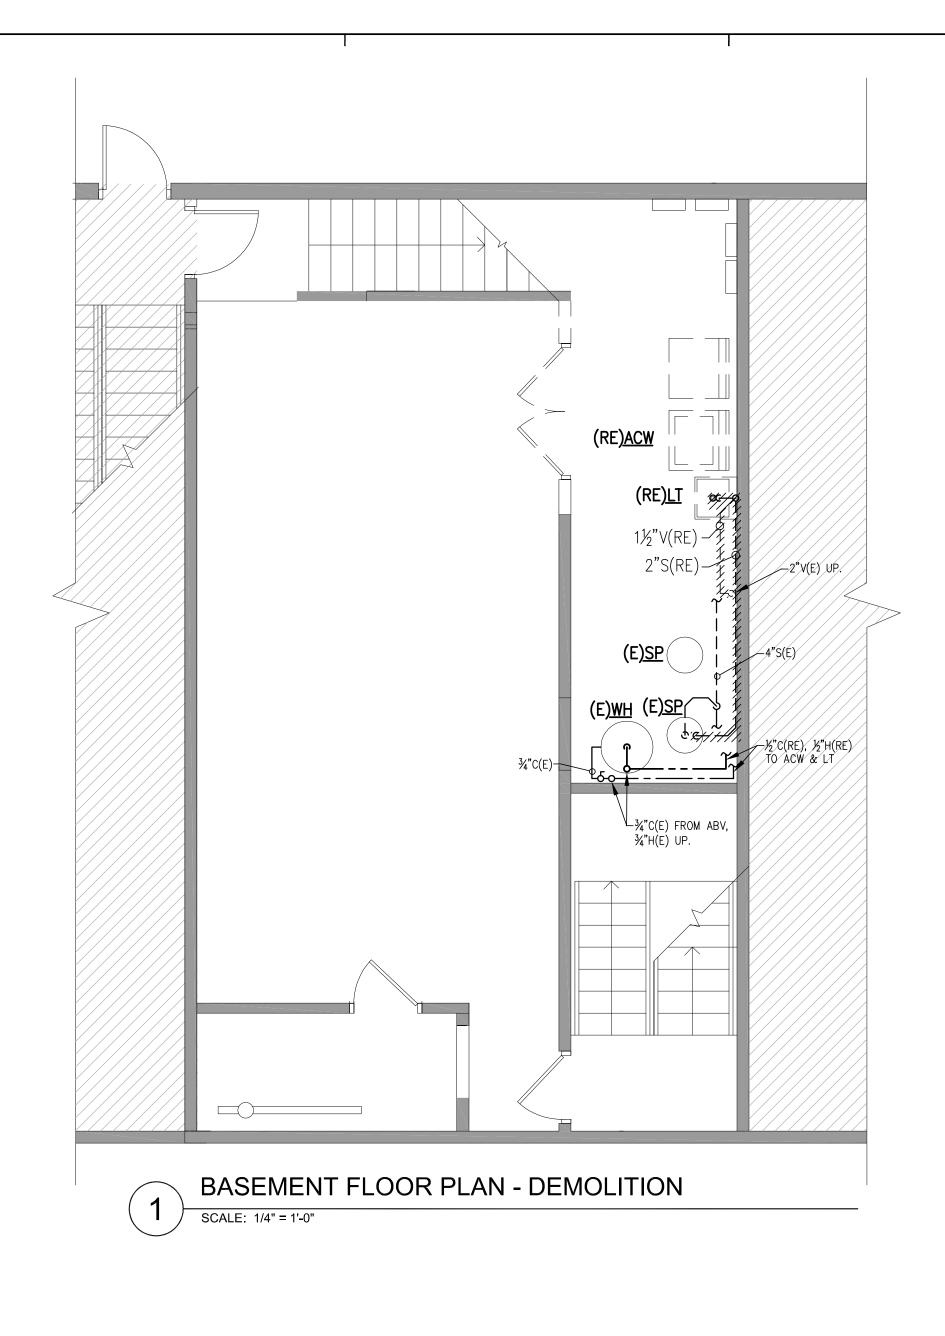


SECOND FLOOR

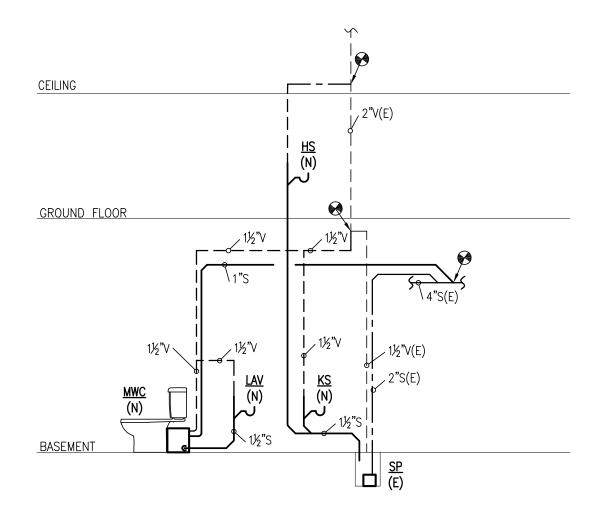

2 SANITARY AND VENT NEW RISER DIAGRAM
SCALE: NOT TO SCALE

SECOND FLOOR

CEILING

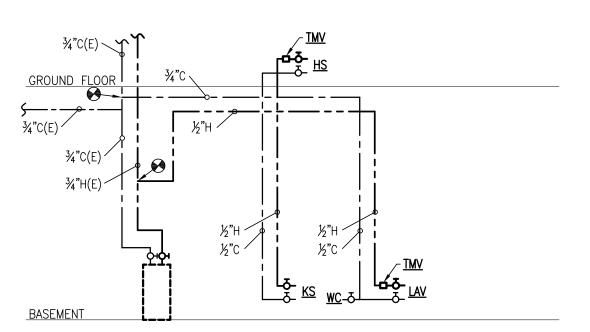

3 DOMESTIC WATER NEW RISER DIAGRAM
SCALE: NOT TO SCALE



Design America Engineering, Inc.

MEP CONSULTING ENGINEERS

14080 Red River Dr. Centreville, VA 20121 Voice:571-220-3239 Fax:703-222-3591 e-mail: daeng2000@aol.com

FE Proje	ect Number:	18-012
ITEM	DESCRIPTION	DATE
	FOR PERMIT	10-26-18

Project/Location:

PROPOSED DOCTOR'S OFFICE 208 Main Street Gaithersburg MD

Owner:

DR. RUPINDER SINGH




PROFESSIONAL CERTIFICATION:
I, RAFAEL COELHO, HEREBY CERTIFY THAT THESE
DOCUMENTS WERE PREPARED OR APPROVED BY ME,
AND THAT I AM A DULY LICENSED PROFESSIONAL
ENGINEER UNDER THE LAWS OF THE STATE OF MARYLAND.
LICENSE # 44287
EXPIRATION DATE: AUGUST 08, 2019

Sheet Title:

PLUMBING
DEMOLITION PLANS
AND NEW RISER
DIAGRAMS

Sheet Number:

P101

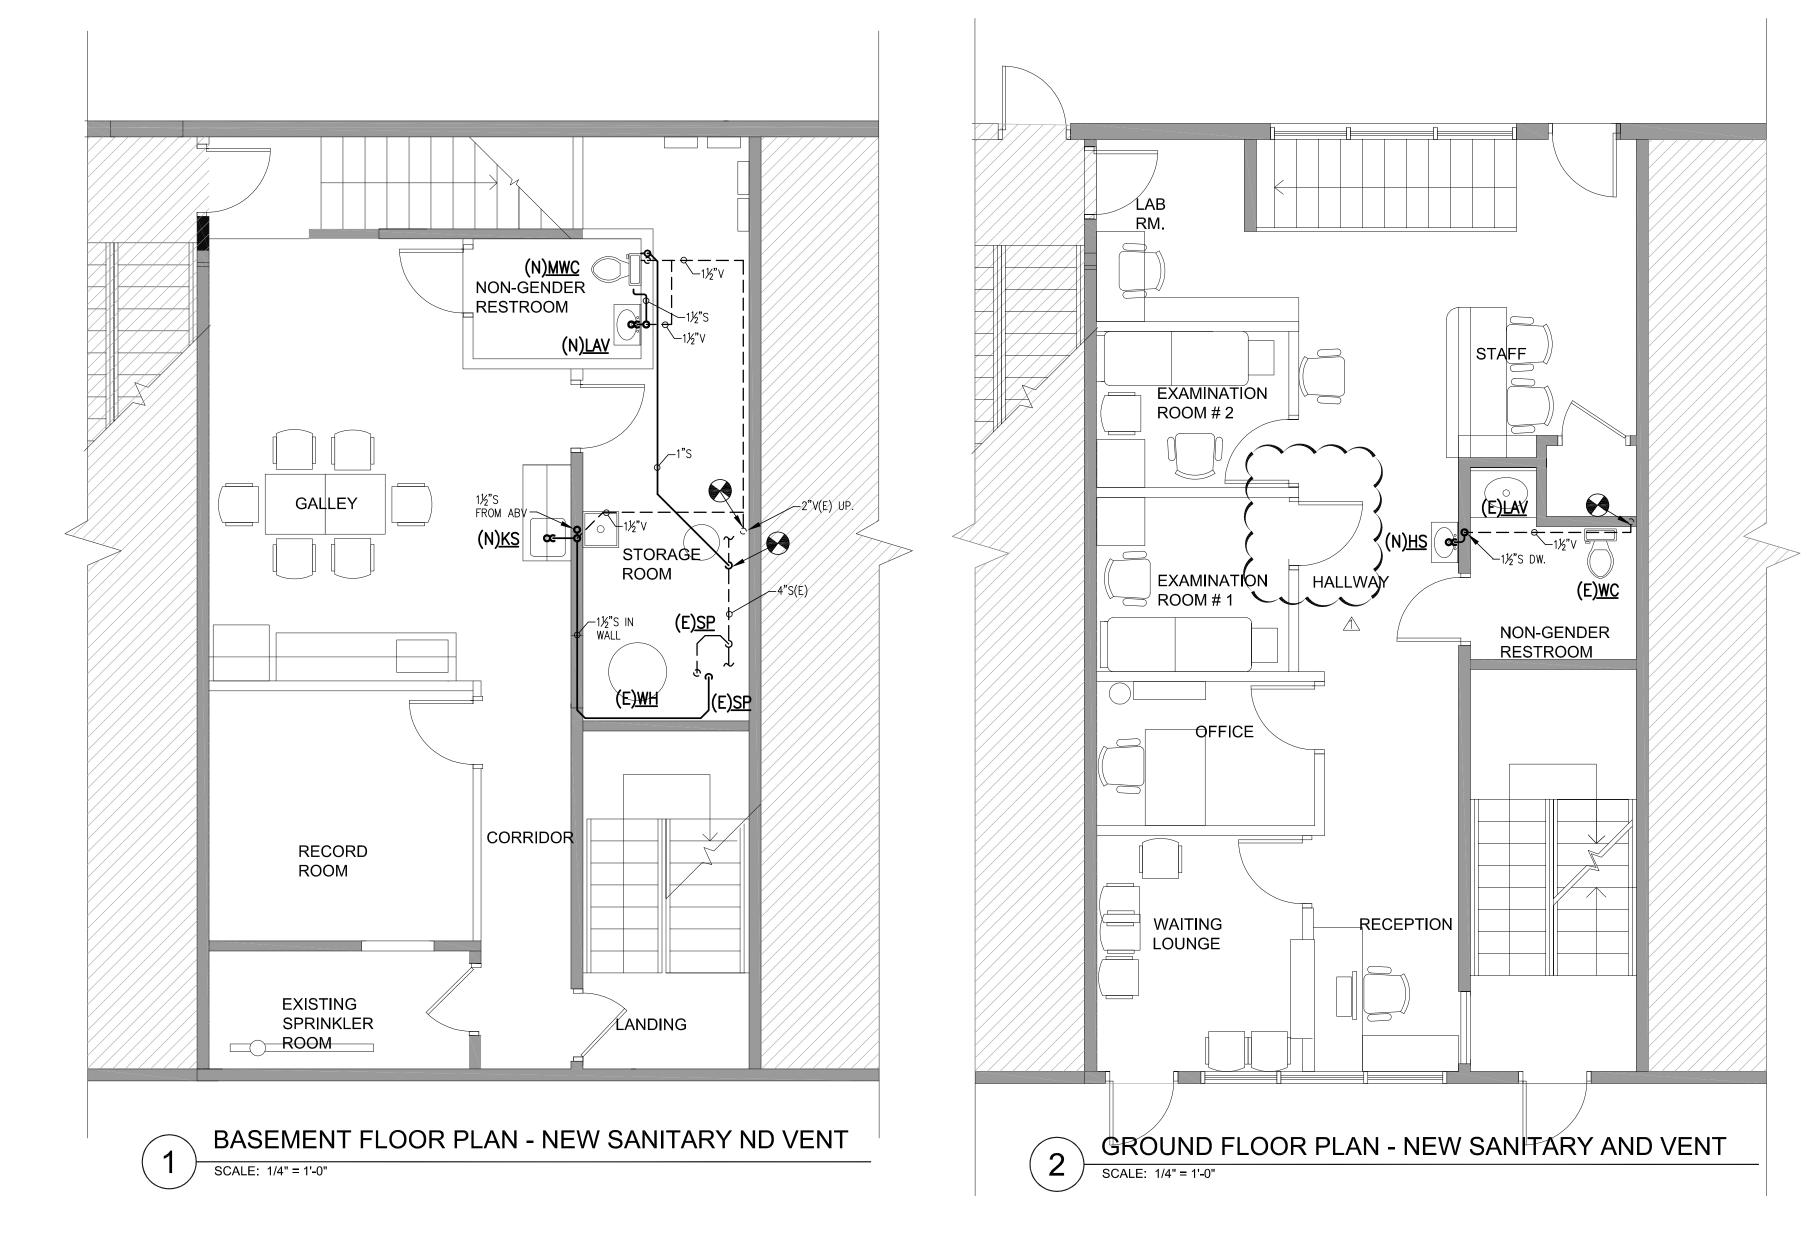

NEW CONSTRUCTION NOTES

- 1. FIELD VERIFY EXISTING DUCT ROUTING CLEARANCE ABOVE CEILING.
- 2. PROVIDE FIRESTOP ON CEILING PENETRATIONS WHERE REQUIRED.
- 3. PROVIDE RADIATION DAMPERS ON CEILING AS



Design America Engineering, Inc.

MEP CONSULTING ENGINEERS

14080 Red River Dr. Centreville, VA 20121 Voice:571-220-3239 Fax:703-222-3591 e-mail: daeng2000@aol.com

FE Proje	18-012	
ITEM	DESCRIPTION	DATE
\triangle	REV.1-C.O.G.COMMENTS	11.15.18

Project/Location:

PROPOSED DOCTOR'S OFFICE 208 Main Street Gaithersburg MD

Owner:

DR. RUPINDER SINGH



PROFESSIONAL CERTIFICATION: I, RAFAEL COELHO, HEREBY CERTIFY THAT THESE

I, RAFAEL COELHO, HEREBY CERTIFY THAT THESE DOCUMENTS WERE PREPARED OR APPROVED BY ME, AND THAT I AM A DULY LICENSED PROFESSIONAL ENGINEER UNDER THE LAWS OF THE STATE OF MARYLAND. LICENSE # 44287 EXPIRATION DATE: AUGUST 08, 2019

Sheet Title:

NEW SANITARY AND VENT PLANS

Sheet Number:

P102

