GENERAL NOTES

- THE CONTRACTOR PROVIDED ESS SHALL BE COMPATIBLE AND FULLY INTEGRATED WITH THE EXISTING GE FACILITY COMMANDER SECURITY MANAGEMENT SYSTEM SERVER LOCATED IN THE MONTGOMERY COLLEGE, GERMANTOWN CAMPUS. THE WORK SHALL INCLUDE THE INSTALLATION OF SYSTEM COMPONENTS, CONDUIT AND RACEWAY SYSTEMS (WHERE NECESSARY), CABLING AND TERMINATION FOR THE SYSTEM SIGNALS AND COMMUNICATIONS, PROGRAMMING AND TESTING OF ALL SYSTEM COMPONENTS.
- 2. CONTRACTOR SHALL FIELD VERIFY AND COORDINATE ALL EXISTING CONDITIONS AND DIMENSIONS INDICATED ON DRAWINGS PRIOR TO EXECUTION OF THIS CONTRACT. THE CONTRACTOR SHALL VERIFY LOCATION OF ALL PARTITIONS PRIOR TO BEGINNING WORK.
- 3. THE TERM "PROVIDE" MEANS FURNISH AND INSTALL, COMPLETE AND READY FOR USE.
- 4. THE TERM "OWNER" MEANS MONTGOMERY COMMUNITY COLLEGE OR ITS DESIGNATED REPRESENTATIVE OR AGENT.
- THE TERM "CONTRACTOR" OR "GENERAL CONTRACTOR" MEANS THE PRIME CONTRACTOR RESPONSIBLE FOR ALL WORK DEFINED IN THE SPECIFICATIONS AND SHOWN ON THE DRAWINGS.
- 6. THE TERM "ELECTRICAL CONTRACTOR" MEANS A LICENSED AND QUALIFIED SUBCONTRACTOR PERFORMING WORK FOR THE CONTRACTOR AS DEFINED IN THE SPECIFICATIONS AND AS SHOWN ON THE DRAWINGS.
- 7. THE TERM "SECURITY CONTRACTOR" MEANS A LICENSED AND QUALIFIED SUBCONTRACTOR PERFORMING WORK FOR THE CONTRACTOR AS DEFINED IN THE SPECIFICATIONS AND AS SHOWN ON THE DRAWINGS.
- 8. THE TERM "CONTRACT DOCUMENTS" MEANS THE SPECIFICATIONS, DRAWINGS, ADDENDUM, SKETCHES, AND OTHER DOCUMENTATION THAT DEFINE THE WORK. ALL CONTRACT DOCUMENTS SHALL BE USED IN COMBINATION TO DEFINE THE WORK REQUIREMENTS. VERIFY ANY CONFLICT BETWEEN DRAWINGS, TECHNICAL SPECIFICATIONS, AND SCHEDULES WITH THE ARCHITECT PRIOR TO PERFORMANCE OF THE WORK.
- 9. THE CONTRACT DRAWINGS ARE DIAGRAMMATIC AND DEFINE THE GENERAL ARRANGEMENT OF DEVICES AND EQUIPMENT. PROVIDE PROJECT MANAGEMENT, ADMINISTRATIVE SUPPORT, SYSTEM DESIGN AND ENGINEERING SERVICES AS REQUIRED.
- 10. PROVIDE ALL LABOR, MATERIAL, EQUIPMENT, WIRE, CABLE, CONDUITS AND RACEWAYS (AS REQUIRED) FOR A COMPLETE INSTALLATION.
- 11. PROVIDE COORDINATION AND VERIFICATION OF ALL CONDITIONS INCLUDING EQUIPMENT AND DEVICES INSTALLED BY OTHER TRADES, TO INCLUDE THE WORK OF THE CONTRACTOR AND SUBCONTRACTORS.
- 12. PROVIDE ALL DOCUMENTATION INCLUDING DESIGN DOCUMENTATION, AS-BUILT DOCUMENTATION, PROGRAMMING WORKSHEETS AND PROJECT COMMUNICATIONS
- 13. FIELD VERIFY AND COORDINATE ALL "NEW WORK" DEVICE LOCATIONS. WHERE CONFLICTS OCCUR, COORDINATE AND VERIFY FINAL LOCATIONS WITH THE OWNER PRIOR TO INSTALLATION.
- 14. CONTRACTOR SHALL PAY ALL FEES AND SHALL OBTAIN ALL PERMITS AND LICENSES AS REQUIRED TO PERFORM THE WORK DEFINED IN THE SPECIFICATIONS AND AS SHOWN ON THE DRAWINGS.
- 15. PROVIDE NEW MATERIAL AND EQUIPMENT THAT CONFORM TO THE APPLICABLE STANDARDS OF UL, NEC, NEMA, ASTM, BICSI AND ANSI.
- 16. ALL WORK SHALL BE GUARANTEED FOR A MINIMUM OF ONE YEAR COMMENCING ON THE DATE OF FINAL ACCEPTANCE BY THE OWNER.
- 17. PROVIDE COORDINATION AND VERIFICATION OF DOOR HARDWARE, EQUIPMENT, AND DEVICES. COORDINATE ALL DOOR HARDWARE FUNCTIONS FOR UNLOCKING, EMERGENCY EGRESS, AND INTERRUPTION OF LOCK POWER BY DOOR HARDWARE EXIT DEVICES.
- 18. PROVIDE INTEGRATION OF SECURITY DEVICES AND EQUIPMENT WITH BUILDING FIRE ALARM DEVICES AND EQUIPMENT TO COMPLY WITH NFPA, NEC AND LOCAL CODES AND ORDINANCES.

CONDUIT NOTES

ABOVE ACCESSIBLE CEILING ROUTE SECURITY CABLE IN SHARED IT CABLE TRAY OR

- ON J-HOOKS.
- 2. IN AREAS WITH HARD CEILING OR NO CEILING ROUTE SECURITY CABLING IN CONDUIT.
- 3. CONDUIT WILL COMPLY WITH NEC AND LOCAL REQUIREMENTS.
- 4. CONTRACTOR SHALL PROVIDE COMPRESSION TYPE CONDUIT FITTINGS. SET SCREW TYPE FITTINGS ARE NOT ACCEPTABLE.
- 5. MOUNT ALL SECURITY CONDUITS AND RACEWAY TO MASONRY WALLS. PAINT ALL SECURITY CONDUITS AND RACEWAYS TO MATCH WALL.
- 6. PAINT ALL JUNCTION BOXES, DEVICE BOXES, TERMINAL CABINETS AND WIRE TROUGH TO MATCH WALL.
- 7. PROVIDE OWNER APPROVED SECURITY SCREWS AND FASTENERS FOR ALL SECURITY JUNCTION BOXES AND SCREW COVER ENCLOSURES.

WIRE AND CABLE NOTES

- PROVIDE ALL WIRE AND CABLE FOR A COMPLETE AND FUNCTIONAL SECURITY
- 2. PROVIDE WIRE AND CABLE THAT COMPLY WITH NEC AND UL REQUIREMENTS OR COMPLY WITH LOCAL CODES AND ORDINANCES. THE MOST STRINGENT REQUIREMENTS SHALL GOVERN.
- WIRE AND CABLE CONDUCTORS FOR DATA CIRCUITS, CONTROL CIRCUITS, AND COMMUNICATIONS WIRING SHALL BE #22 AWG MINIMUM. UP SIZE CONDUCTORS AS REQUIRED TO PROVIDE A MAXIMUM VOLTAGE DROP OF 10%.
- 4. WIRE AND CABLE CONDUCTORS FOR LOW VOLTAGE POWER DISTRIBUTION AND CONTROL CIRCUIT WIRING SHALL BE #18 AWG MINIMUM. UP SIZE CONDUCTORS AS REQUIRED TO PROVIDE A VOLTAGE DROP LESS THAN 10%.
- MANUFACTURER'S INTERNAL INTERCONNECT WIRING SHALL BE UL LISTED AND SIZED IN ACCORDANCE WITH THE MANUFACTURER'S MINIMUM REQUIREMENTS.
- 6. PROVIDE SHIELDED CABLE FOR ALL LOW SPEED SERIAL DATA CIRCUITS, CONTROL CIRCUITS, AND COMMUNICATIONS WIRING.
- 7. PROVIDE UTP CAT6 CABLE FOR ALL HIGH SPEED DATA CIRCUITS (ETHERNET).
- 8. GROUND LOOPS ARE NOT PERMITTED. GROUND SHIELD DRAIN WIRES TO VERIFIED EARTH GROUND TERMINAL LUGS AT THE CONTROL CABINET OR ORIGINATING EQUIPMENT. INSULATE SHIELDS AND DRAIN WIRES AT THE DEVICE OR REMOTE TERMINATION POINT USING UL LISTED INSULATORS. THE USE OF AC POWER NEUTRAL CONDUCTORS FOR GROUND CONNECTIONS IS UNACCEPTABLE.
- 9. PROVIDE UNSHIELDED TWISTED PAIR CABLE ASSEMBLIES FOR ALL DC LOW VOLTAGE POWER DISTRIBUTION AND CONTROL CIRCUITS.
- 10. PROVIDE SHIELDED TWISTED PAIR CABLE ASSEMBLIES FOR ALL AC LOW VOLTAGE POWER DISTRIBUTION.

SYMBOL LIST

YMBOLS.	DESCRIPTION	A
	CONDUIT	٠
\	CONDUIT CONTINUATION	
	CONDUIT TERMINATION	
JB	JUNCTION BOX, SIZED AS REQUIRED	
EX	ELECTRIC LOCK, M - MORTISE LOCK SET	
I	24VDC LOCK POWER SUPPLY	
\emptyset_{X}	MAGNETIC DOOR CONTACT, $X = S$ - SURFACE MOUNT, R - RECESSED MOUNT	
XX ·	CARD READER, X = M - MULLION MOUNT, P - PEDESTAL MOUNT, W - WALL MOUNT	
REX	PASSIVE INFRARED REQUEST TO EXIT DEVICE	
D _{PB}	PUSH BUTTON REQUEST TO EXIT DEVICE	
	LOCAL SOUNDER	
ACP	ACCESS CONTROL PANEL (READER MODULES, INPUT/OUTPUT MODULES AS REQUIRED)	
NS	NETWORK SWITCH	
Z	120VDC 20A EMERGENCY POWER CIRCUIT (PROVIDED BY ELECTRICAL CONTACTOR)	

	ABBREVIATIONS
ABBREVIATION	DESCRIPTION
AC	ALTERNATE CURRENT
ACS	ACCESS CONTROL SYSTEM
ADA	AMERICANS WITH DISABILITIES ACT
AFF	ABOVE FINISHED FLOOR
ANSI	AMERICAN NATIONAL STANDARDS INSTITUTES
APPROX	APPROXIMATE
ASTM	ASTM INTERNATIONAL
ATC	ACOUSTICAL TILE CEILING
AWG	AMERICAN WIRE GAUGE
BICSI	BUILDING INDUSTRY CONSULTING SERVICE INTERNATIONAL
С	CONDUCTOR
CAB	COUNSELING AND ADVISING BUILDING
CCTV	CLOSED CIRCUIT TELEVISION
СМ	CEILING MOUNTED
COMM	COMMUNICATION
DAR	DISCONNECT AND REMOVE
DC	DIRECT CURRENT
DVR	DIGITAL VIDEO RECORDER
EMT	ELECTRICAL METALLIC TUBING
ESS	ELECTRONIC SECURITY SYSTEM
IDS	INTRUSION DETECTION SYSTEM
IN	INTERIOR TYPE ENCLOSURE
IP	INTERNET PROTOCOL
MCF-NET	MONTGOMERY COLLEGE FACILITIES NETWORK
MDF	MAIN DISTRIBUTION FRAME
MTD	MOUNTED
NEC	NATIONAL ELECTRIC CODE
NEMA	NATIONAL ELECTRICAL MANUFACTURERS ASSOCIATION
NFPA	NATIONAL FIRE PROTECTION ASSOCIATION
NC	NETWORK INTELLIGENT CONTROLLER
NTS	NOT TO SCALE
PC	PERSONAL COMPUTER
PoE	POWER OVER ETHERNET
PIR	PASSIVE INFRARED
PR	PAIR
PSU	POWER SUPPLY UNIT
RM	ROOM
RRE	REMOTE READER ELECTRONICS
RRM	REMOTE RELAY OUTPUT MODULE
RTE	REQUEST-TO-EXIT
SMS	SECURITY MANAGEMENT SYSTEM
TBD	TO BE DETERMINED
TSP	TWISTED SHIELDED PAIR
TYP	TYPICAL
UL	UNDERWRITERS LABORATORIES
UPS	UNINTERRUPTED POWER SUPPLY
UNO	UNLESS NOTED OTHERWISE
1460	LOUTO ALTERNATINO OURSELT

VOLTS ALTERNATING CURRENT

WEATHER PROOF TYPE ENCLOSURE

WALL MOUNTED

SIMPSON GUMPERTZ & HEGER

| Engineering of Structures and Building Enclosures

Simpson Gumpertz & Heger Inc. 1828 L Street NW, Suite 950 Washington, DC 20036 main: 202.239.4199 fax: 202.239.4198 www.sgh.com

Door Hardware

Consultant

Security

Consultant

Chicago Los Angele New York San Francisco Washington, DC

Erbschloe Consulting Services, Inc. 7820 Carters Run Drive Marshall, VA 20115

GHD, Inc. 14585 Avion Parkway, Suite 150 Chantilly, VA 20151 571.325.5000

540.351.0553

Cost Estimating Forella Group, LLC. Consultant 9495 Silver King Ct., Suite A Fairfax, VA 22031 703.560.2200

Consultant

PHYSICAL EDUCATION BLDG **EXTERIOR RENOVATION** MONTGOMERY COLLEGE **GERMANTOWN CAMPUS**

Bid Set County Response Set

100% Design Development

Description

Pricing/Permit Set


20200 OBSERVATION DRIVE GERMANTOWN, MD 20876

No. Date


REFERENCE SHEET **SECURITY**

Drawing Title

150049.01 DMS 01/22/16 AS NOTED Drawing No.

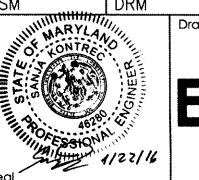

SANJA KONTREC, PE License No. 46280 Professional Certification: I hereby certify that these documents were prepared or approved by me, and that I am a duly licensed professional engineer under the laws of the State of Maryland, License No. 46280, Expiration Date: December 29, 2016

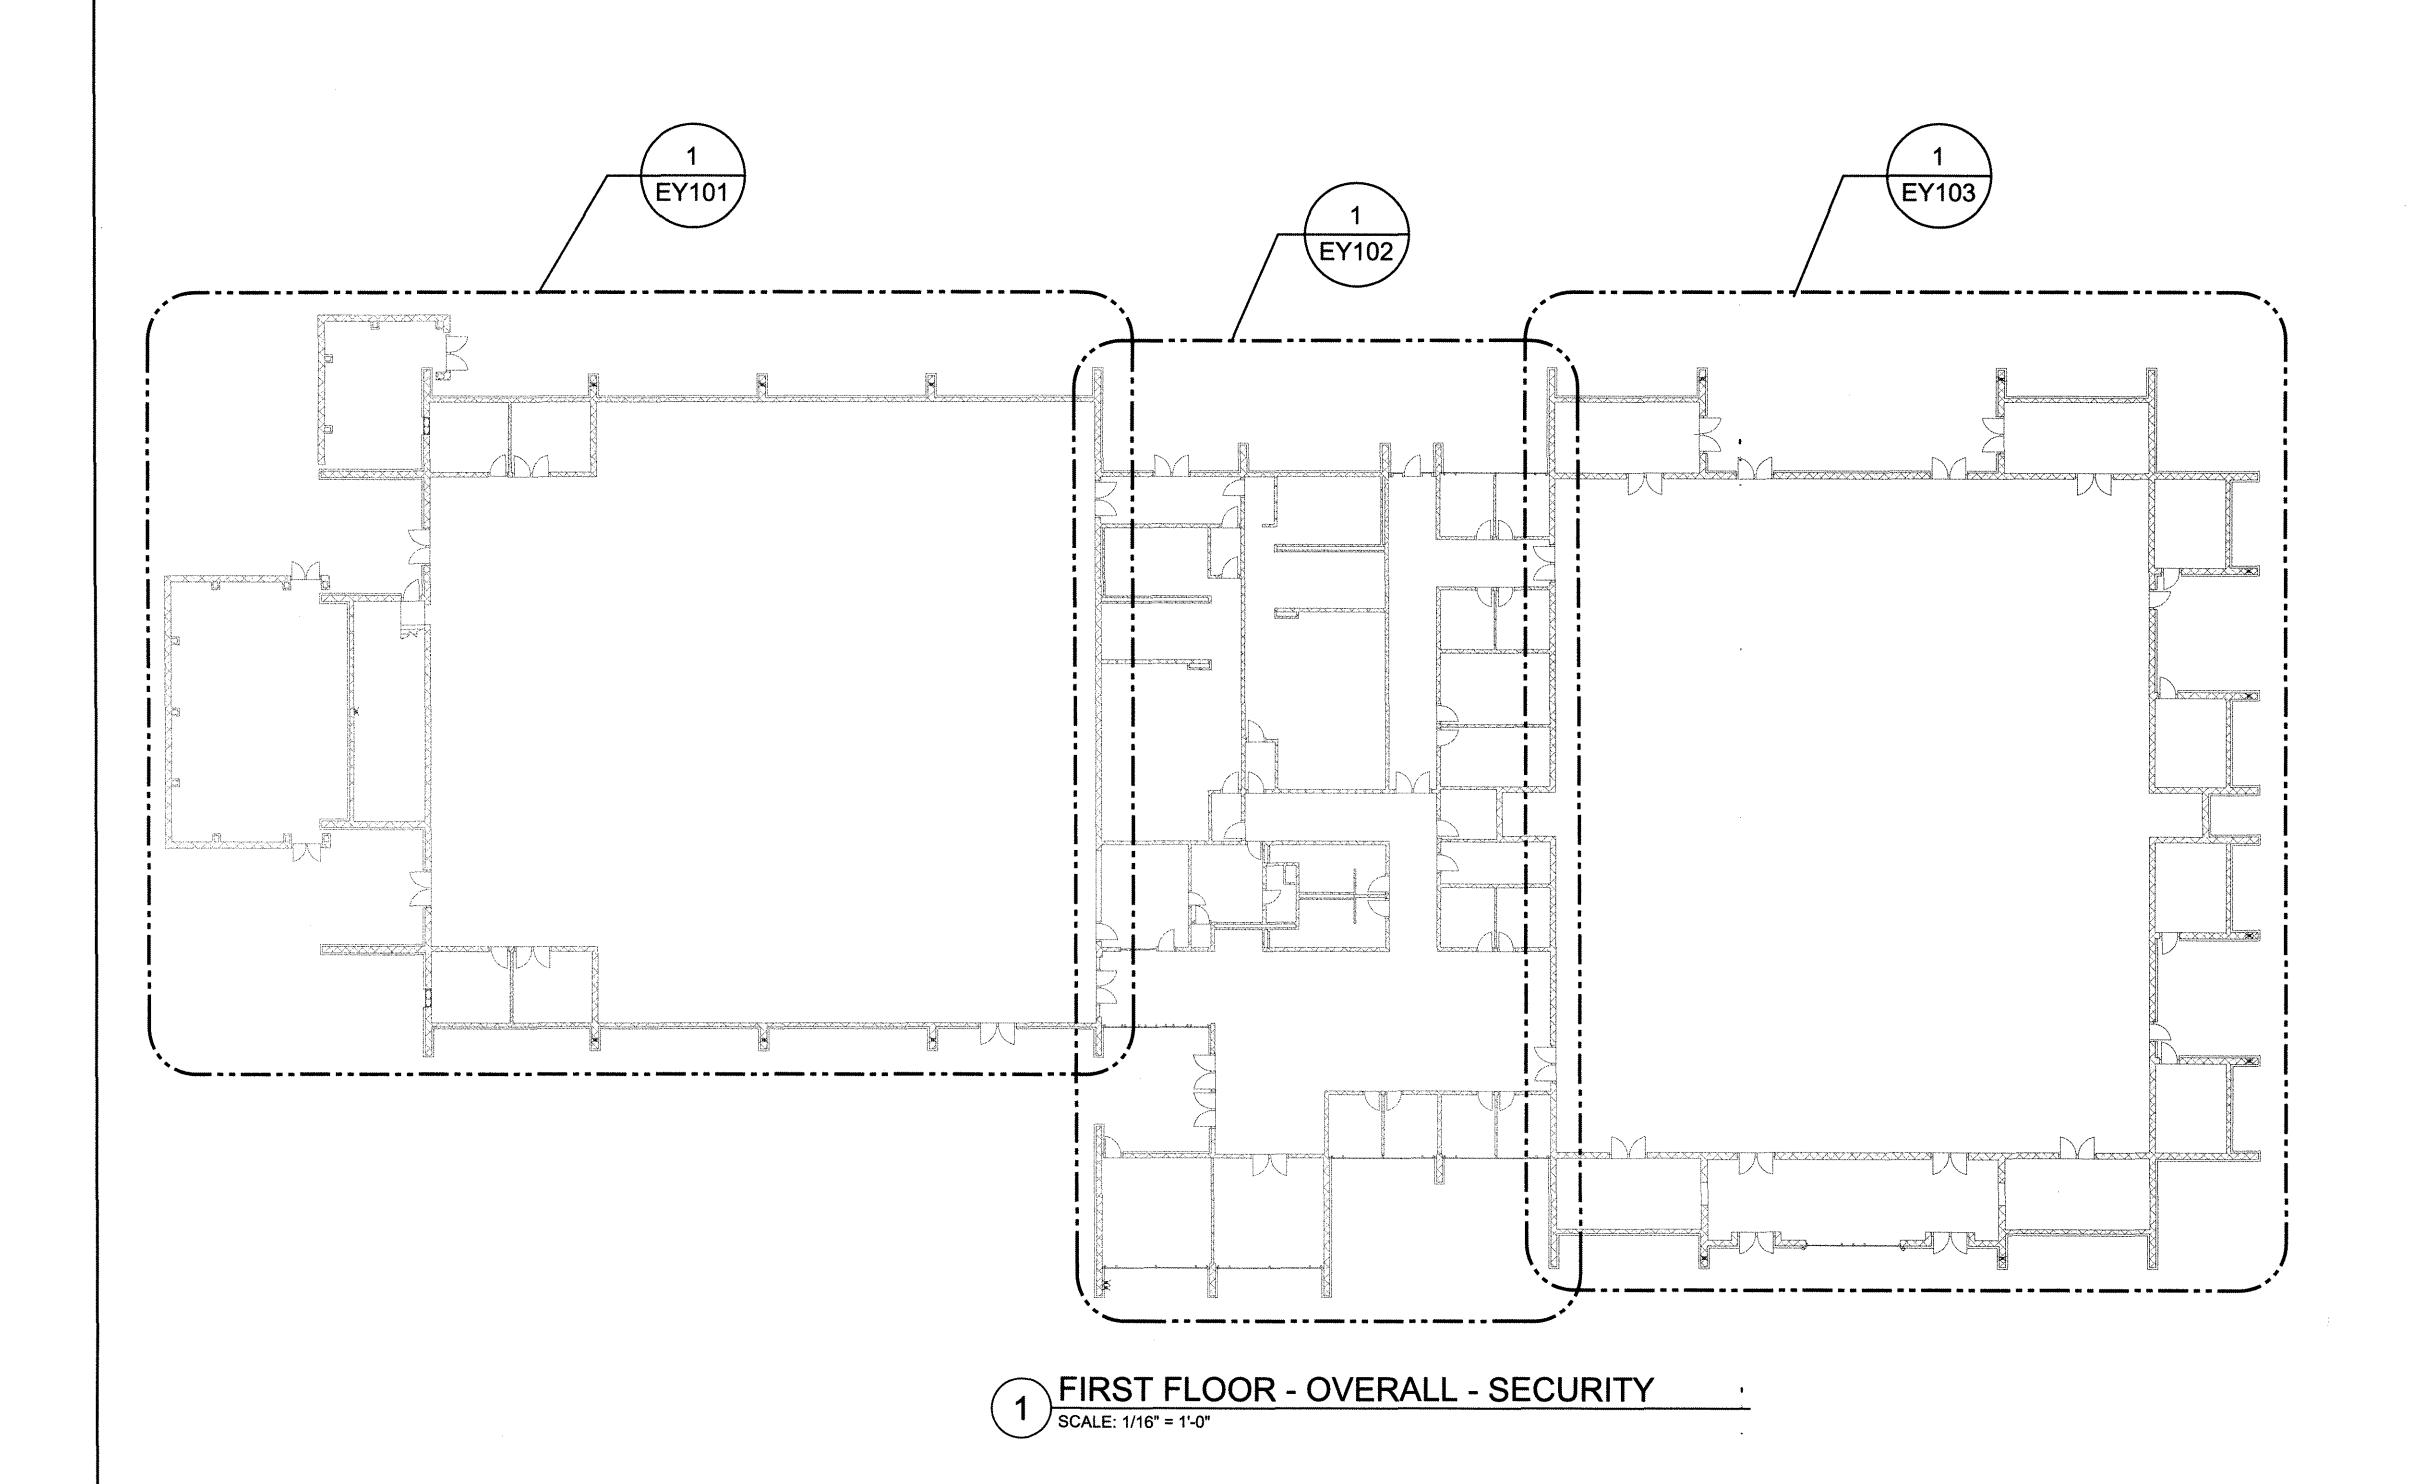

SIMPSON GUMPERTZ & HEGER

Engineering of Structures and Building Enclosures

Simpson Gumpertz & Heger Inc. 1828 L Street NW, Suite 950 Washington, DC 20036 main: 202,239,4199 fax: 202,239,4198 www.sgh.com

Chicago Los Angeles New York San Francisco Washington, DC

Consultant

Erbschioe Consulting Services, inc. 7820 Carters Run Drive Marshall, VA 20115 540.351.0553

GHD, Inc. 14585 Avion Parkway, Suite 150 Chantilly, VA 20151 571.325.5000

Forella Group, LLC. 9495 Silver King Ct., Suite A Fairfax, VA 22031 703.560.2200

Consultant

Cost Estimating Consultant

Security Consultant

BIL

Bid Set County Response Set

Pricing/Permit Set 100% Design Development

PHYSICAL EDUCATION BLDG **EXTERIOR RENOVATION** MONTGOMERY COLLEGE GERMANTOWN CAMPUS 20200 OBSERVATION DRIVE GERMANTOWN, MD 20876


OVERALL FIRST FLOOR PLAN SECURITY

Drawing Title

Date 01/22/16 Scale AS NOTED Project No. 150049.01 Checked DMS



SANJA KONTREC, PE License No. 46280 01/22/16
Professional Certification: I hereby certify that these documents were prepared or approved by me, and that I am a duly licensed professional engineer under the laws of the State of Maryland, License No. 46280, Expiration Date: December 29, 2016

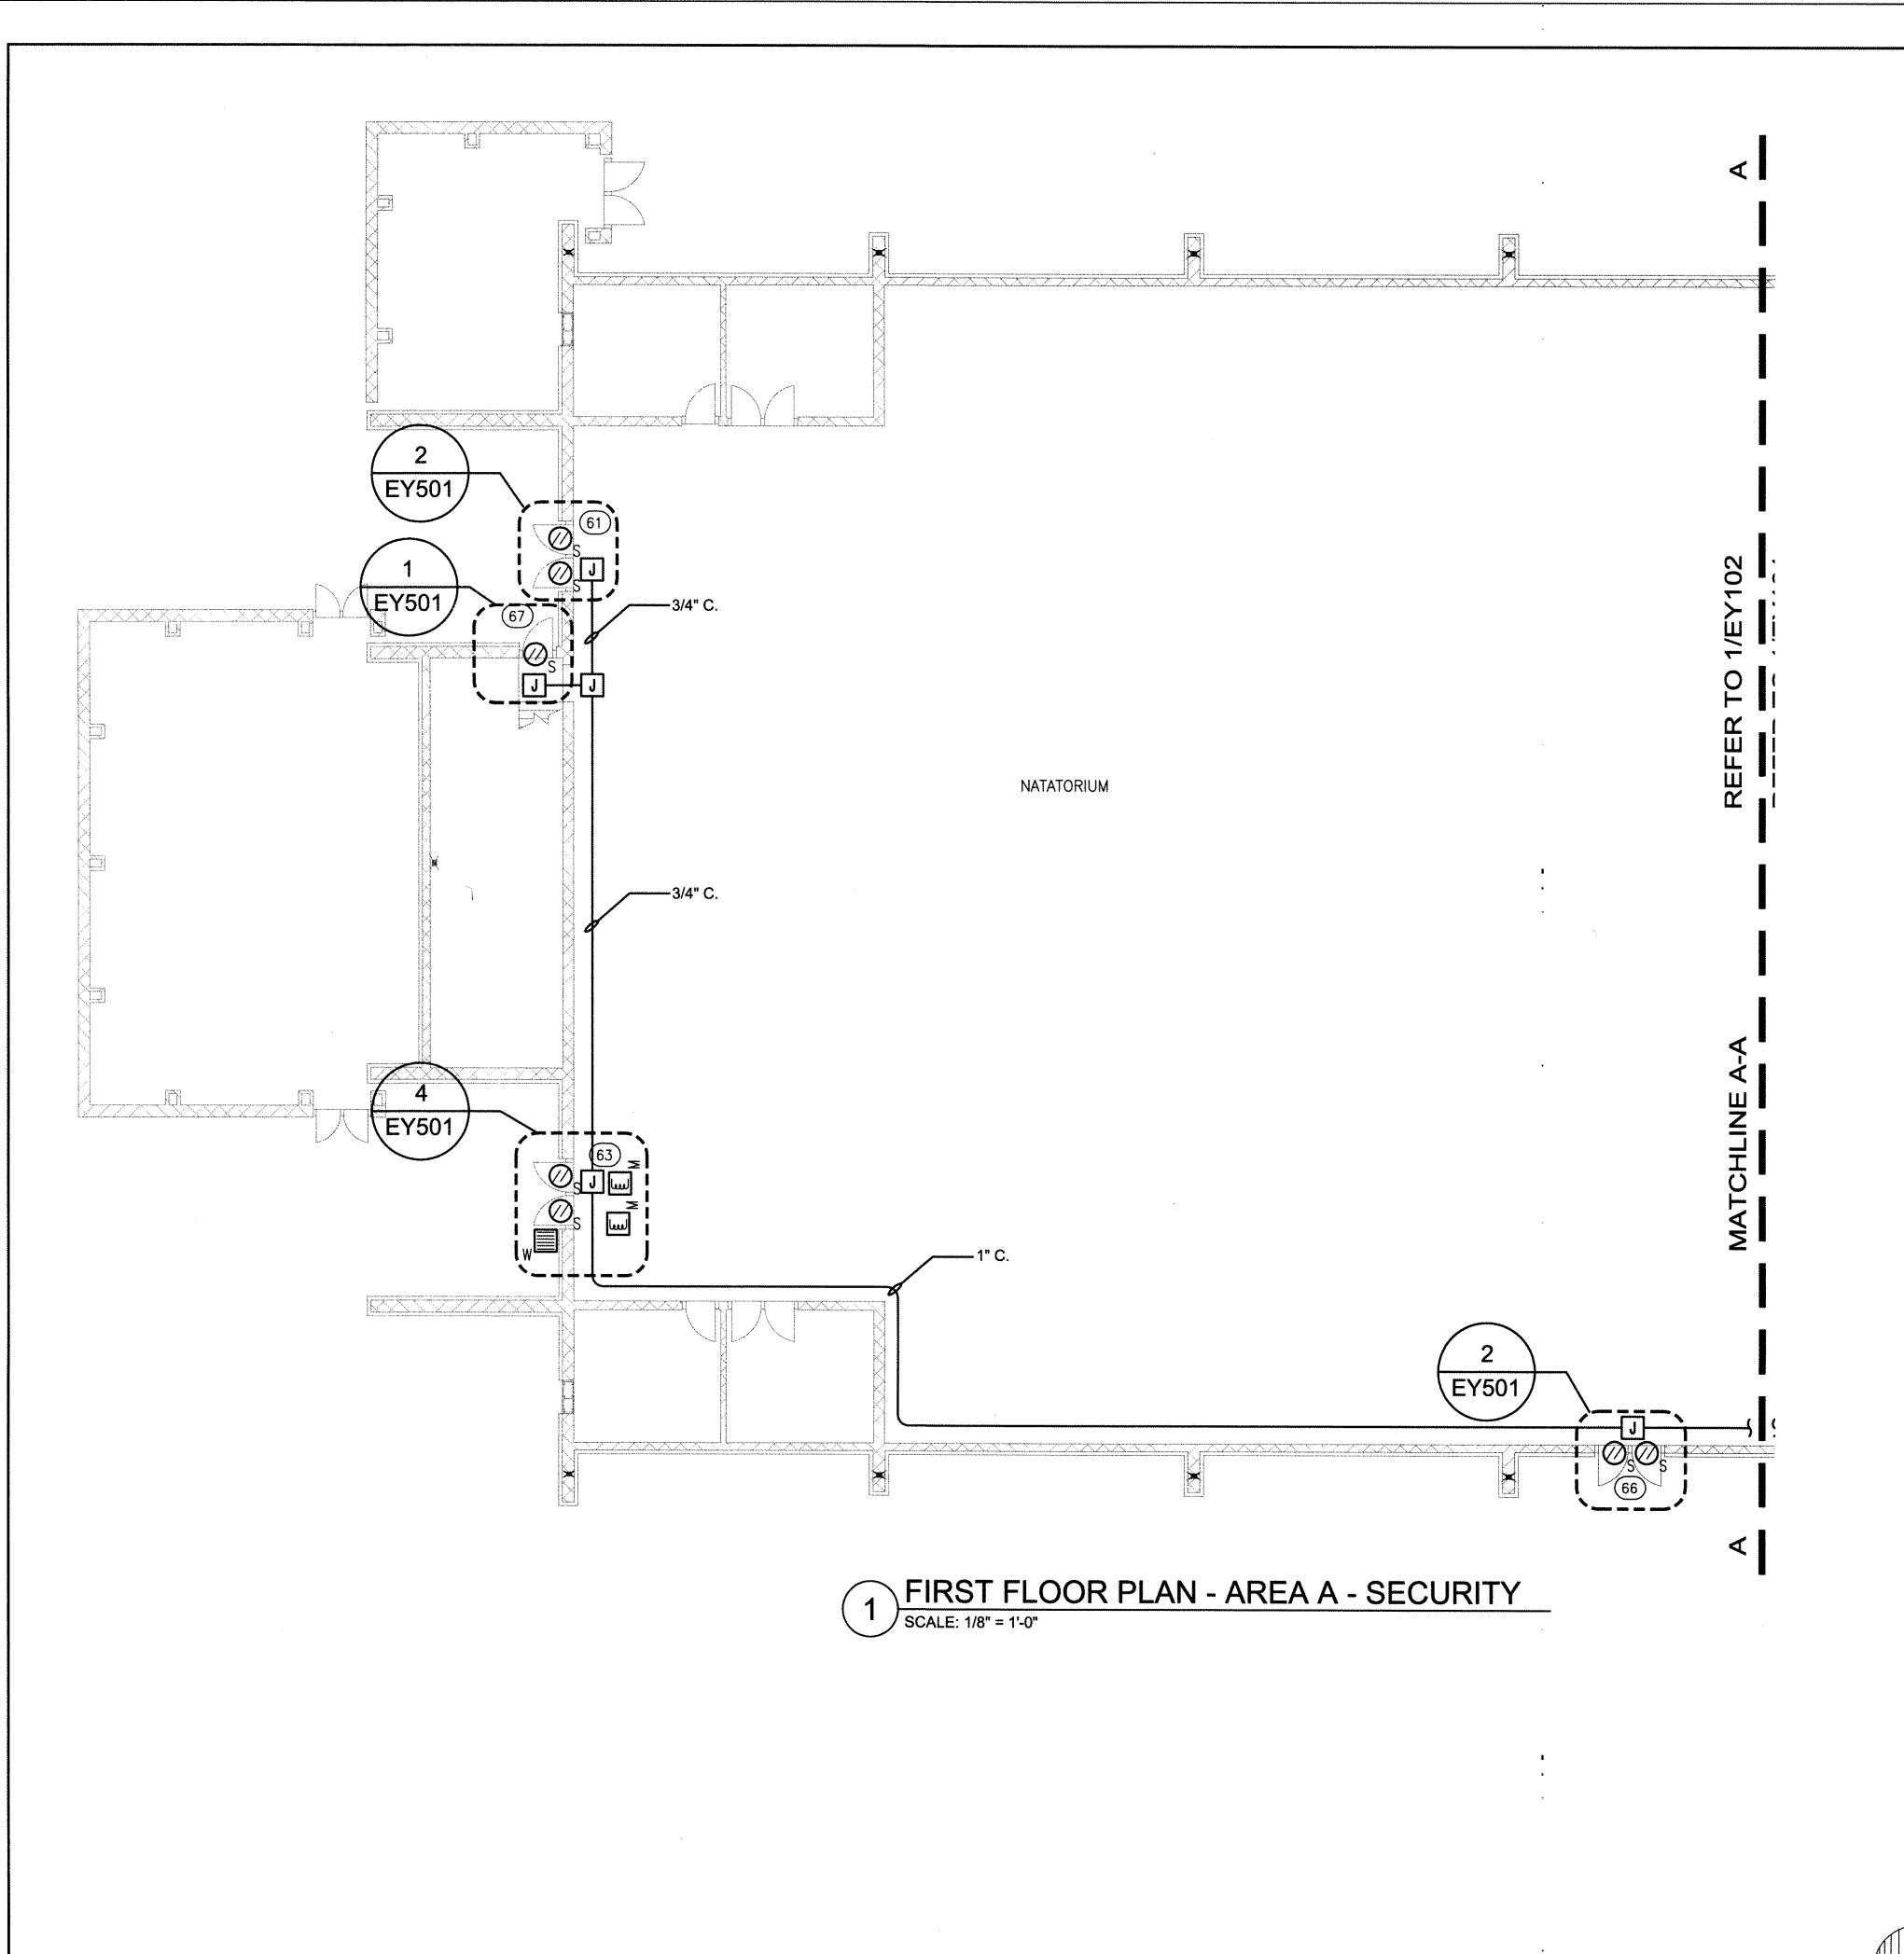

SHEET NOTES

- 1. WIRE DOOR CONTACTS IN SERIES FOR EACH SET OF : DOUBLE DOORS.
- 2. PAINT SURFACE MOUNTED CONDUIT TO MATCH WALLS.
- 3. MOUNT CONDUIT TO MASONRY WALL A MINIMUM OF 10' AFF.

SIMPSON GUMPERTZ & HEGER

| Engineering of Structures | and Building Enclosures

Simpson Gumpertz & Heger Inc. 1828 L Street NW, Suite 950 Washington, DC 20036 main: 202.239.4199 fax: 202.239,4198 www.sgh.com

Chicago Los Angeles New York San Francisco Washington, DC

Door Hardware Consultant

Erbschloe Consulting Services, Inc. 7820 Carters Run Drive Marshall, VA 20115 540.351.0553

GHD, Inc. 14585 Avion Parkway, Suite 150

Chantilly, VA 20151 571.325.5000

Forella Group, LLC. 9495 Silver King Ct., Suite A Fairfax, VA 22031 703.560.2200 Cost Estimating

Consultant

Consultant

- 1						
ı						
	\triangle	01/22/16	Bid Set County Response Set			
		11/20/15	Pricing/Permit Set			
		08/28/15	100% Design Development			
	No.	Date	Description	Ву		


PHYSICAL EDUCATION BLDG **EXTERIOR RENOVATION** MONTGOMERY COLLEGE GERMANTOWN CAMPUS 20200 OBSERVATION DRIVE GERMANTOWN, MD 20876

PARTIAL FIRST **FLOOR PLAN** SECURITY

cked Date
S 01/22/16
roved Scale M Scale AS NOTED
Drawing No.

EY101

SANJA KONTREC, PE License No. 46280 01/22/16
Professional Certification: I hereby certify that these documents were prepared or approved by me, and that I am a duly licensed professional engineer under the laws of the State of Maryland, License No. 46280, Expiration Date: December 29, 2016 KEY PLAN

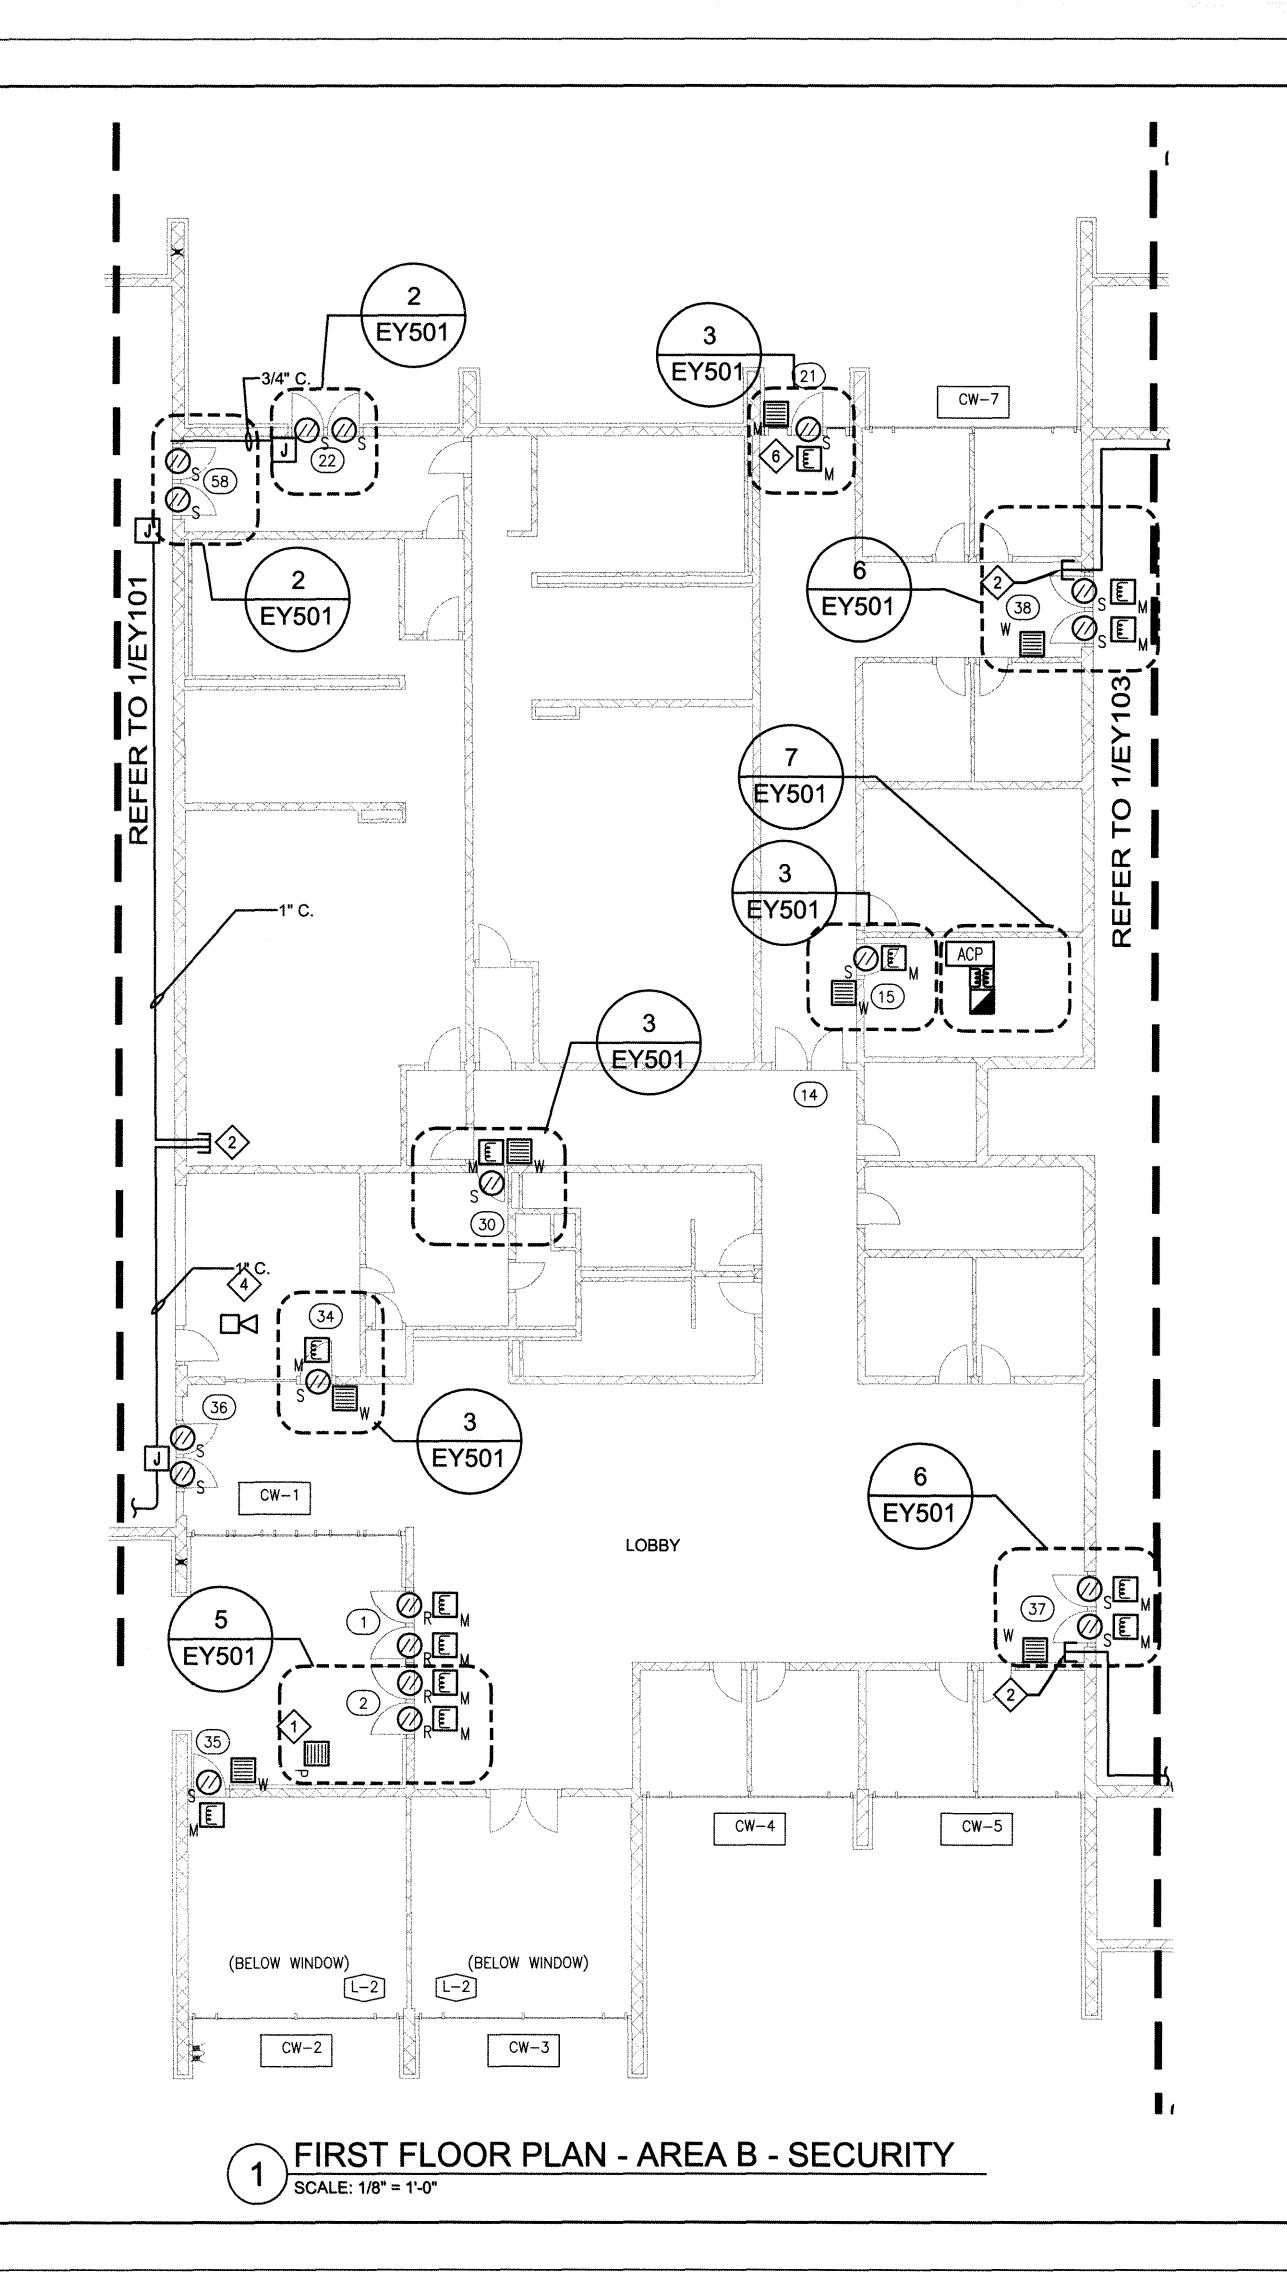

SHEET NOTES

- 1. PAINT SURFACE MOUNTED CONDUIT TO MATCH WALLS.
- 2. MOUNT CONDUIT TO MASONRY WALL A MINIMUM OF 10' AFF.

SIMPSON GUMPERTZ & HEGER Engineering of Structures and Building Enclosures

Simpson Gumpertz & Heger Inc. 1828 L Street NW, Suite 950 Washington, DC 20036 main: 202.239.4199 fax: 202.239.4198 www.sgh.com Washington, DC

Los Angeles New York

San Francisco

Door Hardware Consultant

Erbschioe Consulting Services, inc. 7820 Carters Run Drive Marshall, VA 20115 540.351.0553

GHD, Inc. 14585 Avion Parkway, Suite 150 Chantilly, VA 20151

571.325.5000 Forella Group, LLC. 9495 Silver King Ct., Suite A Fairfax, VA 22031

703.560.2200

Consultant

Cost Estimating Consultant

Security Consultant

MOUNT CARD READER TO EXISTING ADA PEDESTAL. INTEGRATE ACS WITH ADA OPERATOR.

KEY NOTES

- CONTINUE SECURITY CABLE TO IT CLOSET ON J-HOOKS ABOVE ATC.
- ROUTE NEW SECURITY CABLING IN EXISTING BULK HEAD TO IT CLOSET.
- WALL MOUNT SOUNDER ABOVE DOOR OR ON ADJACENT WALL.
- 5 MOUNT ACP BEHIND DOOR IN TELECOM CLOSET. INSTALL DOOR STOP IN FLOOR TO PREVENT FDOOR FROM DAMAGING PANELS.
- 6 120 VAC, 20 A POWER AT DOOR (BY OTHERS).


图

Bid Set County Response Set Pricing/Permit Set 100% Design Development

PHYSICAL EDUCATION BLDG **EXTERIOR RENOVATION** MONTGOMERY COLLEGE GERMANTOWN CAMPUS 20200 OBSERVATION DRIVE GERMANTOWN, MD 20876


PARTIAL FIRST FLOOR PLAN **SECURITY**

Project No. 150049.01 Date 01/22/16 Scale AS NOTED Drawing No.

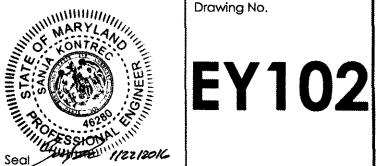

SANJA KONTREC, PE License No. 46280 Professional Certification: I hereby certify that these documents were prepared or approved by me, and that I am a duly licensed professional engineer under the laws of the State of Maryland, License No. 46280, Expiration Date: December 29, 2016

KEY PLAN

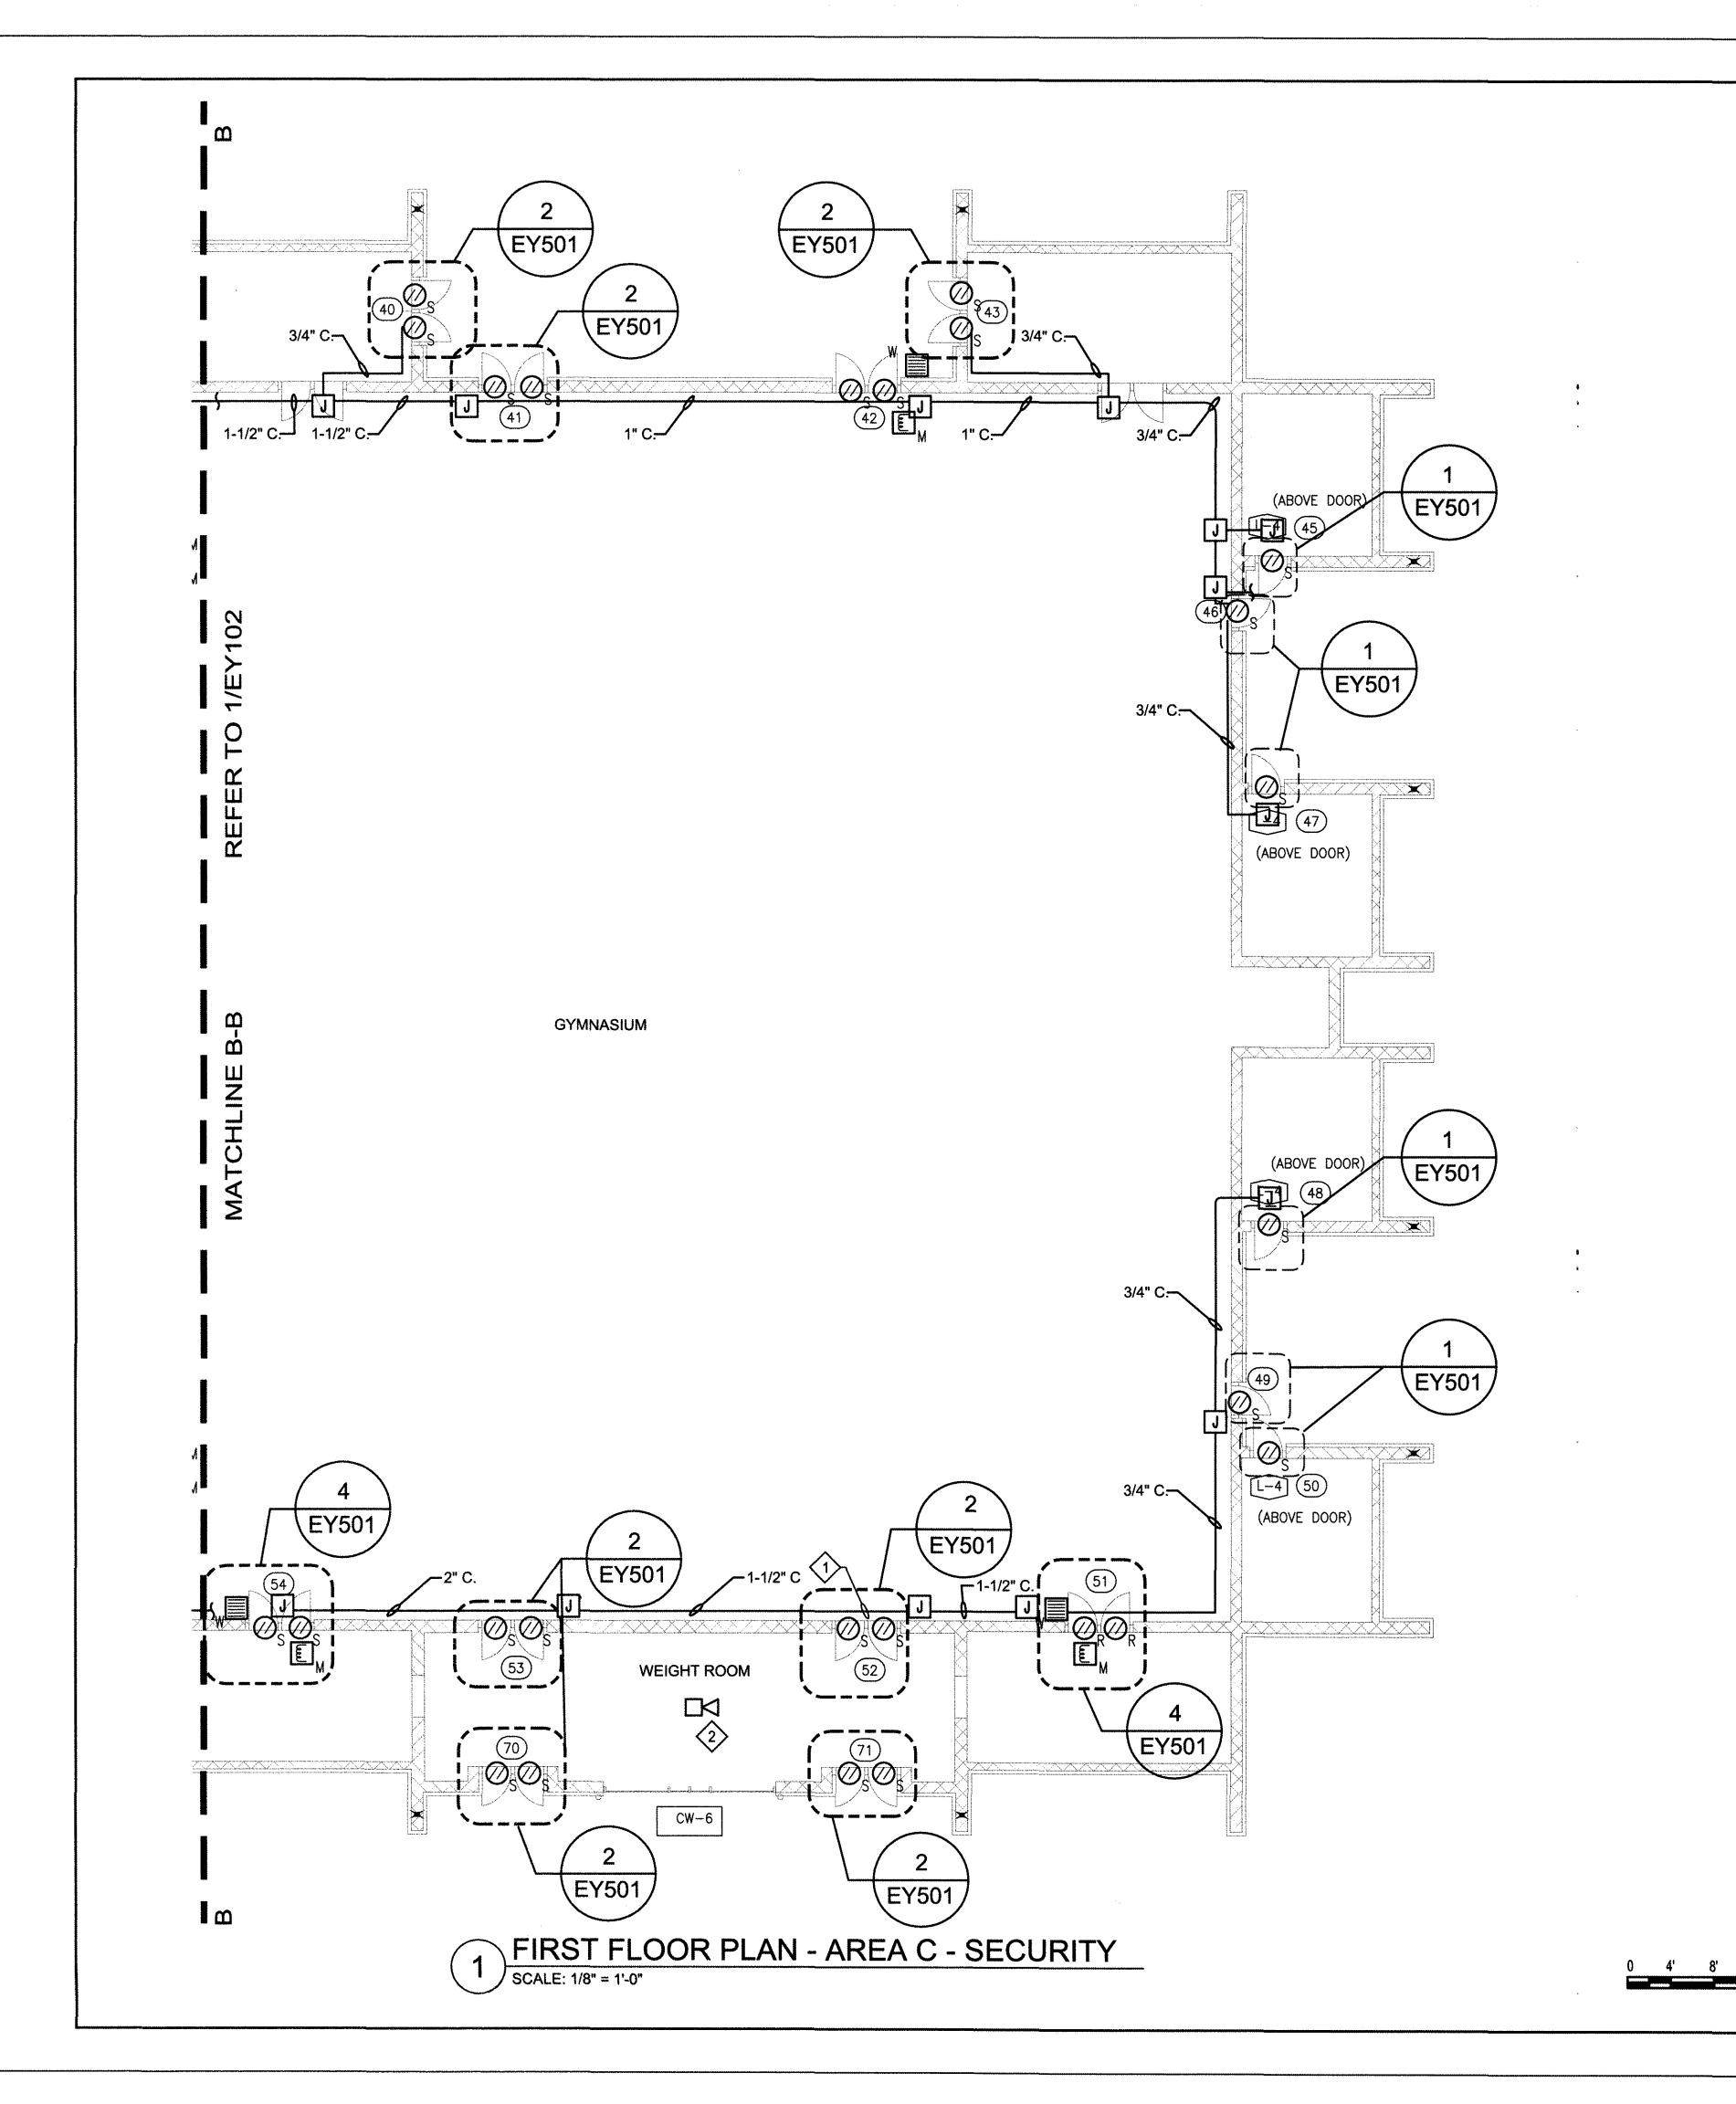

SHEET NOTES

1. MOUNT CONDUIT TO MASONRY WALL A MINIMUM OF 10 FEET AFF.

KEY NOTES

1) INSTALL NEW SURFACE MOUNTED CONDUIT IN GYMNASIUM. ROUTE SECURITY CABLING IN

CONDUIT.

2 CEILING MOUNT SOUNDER.

2. PAINT CONDUIT TO MATCH WALLS.



SIMPSON GUMPERTZ & HEGER

Engineering of Structures and Building Enclosures

Simpson Gumpertz & Heger Inc. 1828 L Street NW, Suite 950 Washington, DC 20036 main: 202.239.4199 fax: 202.239.4198 www.sgh.com

Chicago Los Angeles New York San Francisco Washington, DC

Door Hardware Consultant

Erbschioe Consulting Services, Inc. 7820 Carters Run Drive Marshall, VA 20115 540.351.0553

Security Consultant

GHD, Inc. 14585 Avion Parkway, Suite 150 Chantilly, VA 20151 571.325.5000

Cost Estimating Consultant

Forella Group, LLC. 9495 Silver King Ct., Suite A Fairfax, VA 22031 703.560.2200

Consultant

· | | L

BID SET

01/22/16 Bid Set County Response Set

11/20/15 Pricing/Permit Set

08/28/15 100% Design Development

No. Date Description


PHYSICAL EDUCATION BLDG
EXTERIOR RENOVATION
MONTGOMERY COLLEGE
GERMANTOWN CAMPUS
20200 OBSERVATION DRIVE
GERMANTOWN, MD 20876

Dunin nt

PARTIAL FIRST FLOOR PLAN SECURITY

Drawing Title

Project No. 150049.0	Checked 1 DMS	Date 01/22/16
Drawn MSM	Approved DRM	Scale AS NOTED
HO KO	TRECO DE	awing No.

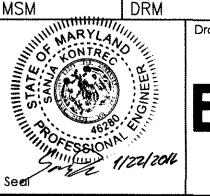


EY103

SANJA KONTREC, PE License No. 46280 01/22/16

Professional Certification: I hereby certify that these documents were prepared or approved by me, and that I am a duly licensed professional engineer under the laws of the State of Maryland, License No. 46280, Expiration Date: December 29, 2016

KEY PLAN

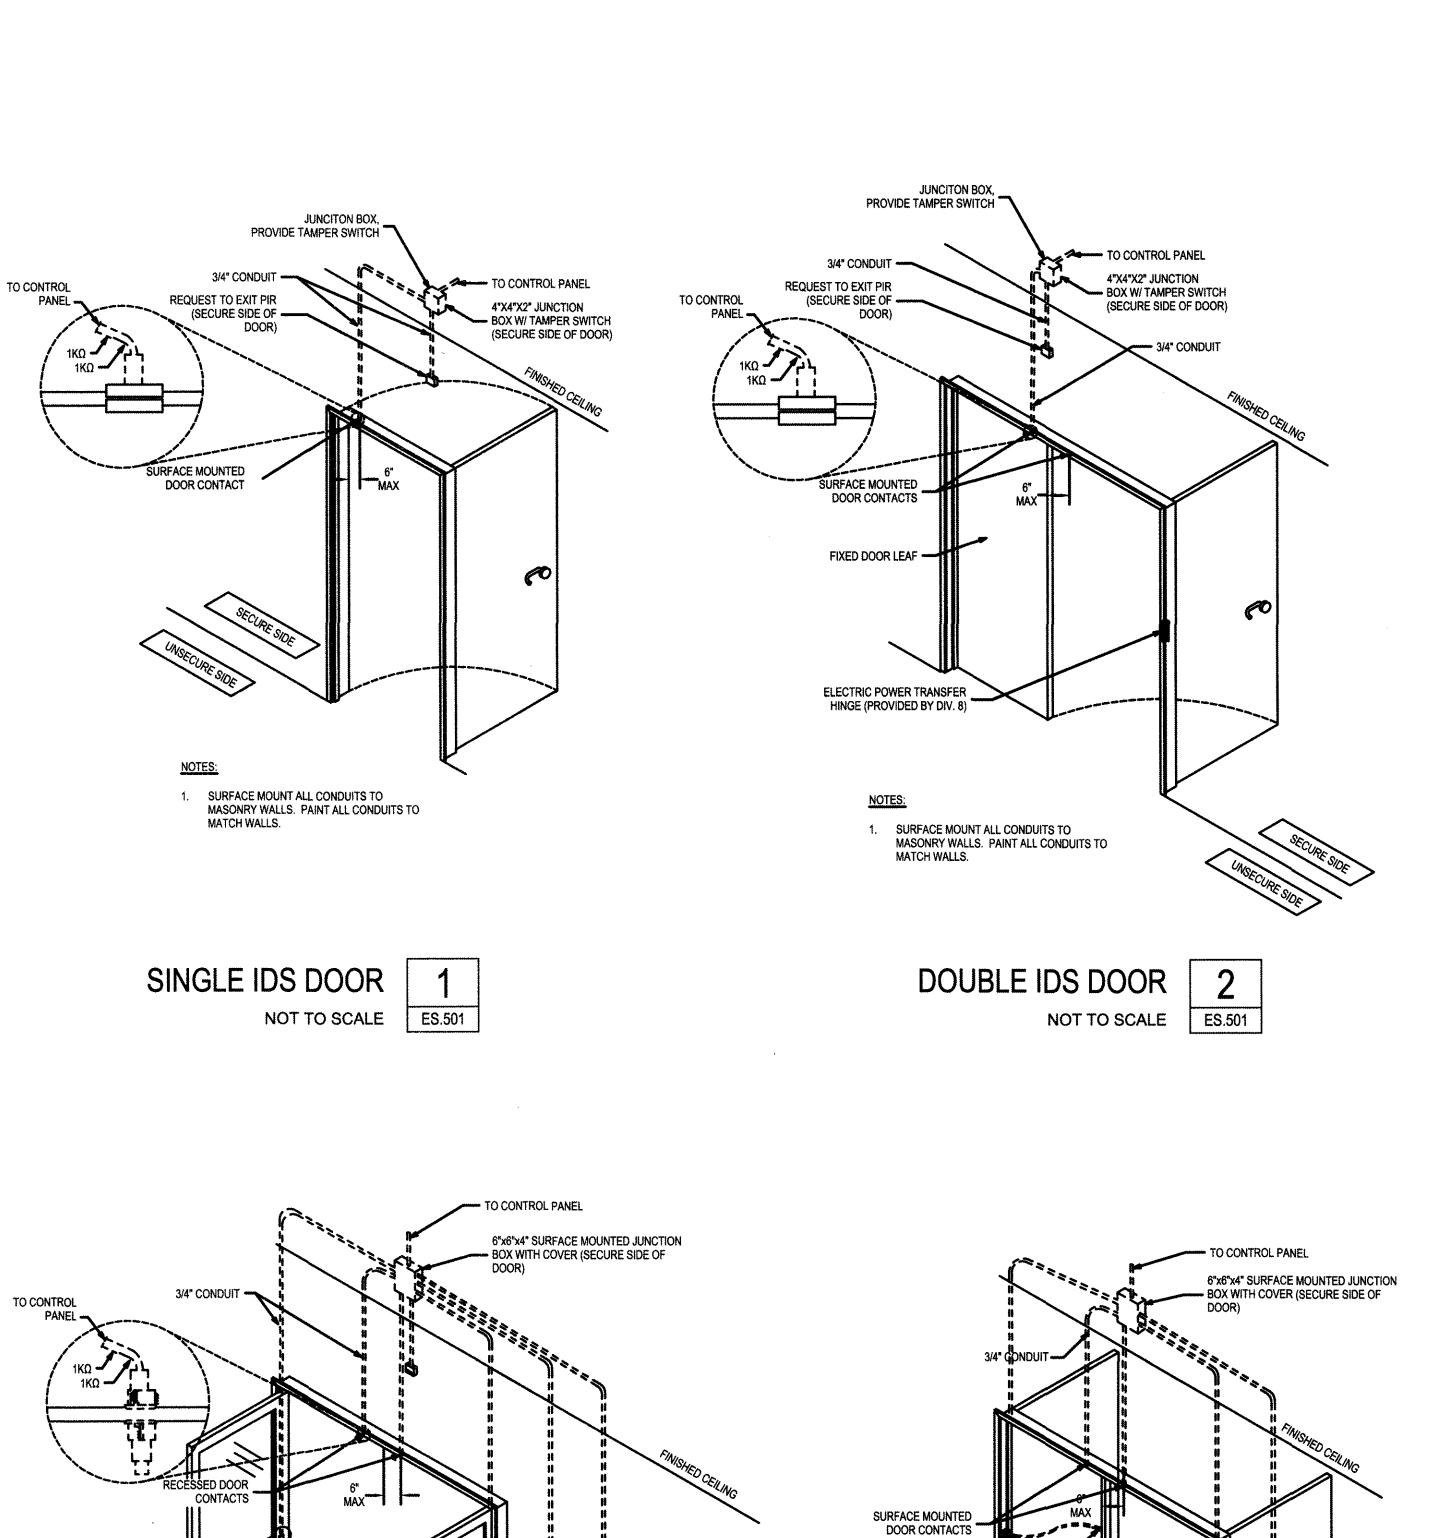

POWER PASS THROUGH

PROVIDED BY

DEVICE

ADA OPERATOR (PROVIDED BY OTHERS)

READER (AS REQUIRED)

READER PEDESTAL (PROVIDED BY OTHERS)

DOUBLE ACS DOOR WITH MORTISE LOCKSET


W/ INTEGRATED REX

NOT TO SCALE

ES.501

SURFACE MOUNT ALL CONDUITS TO MASONRY WALLS. PAINT ALL CONDUITS TO


MATCH WALLS.

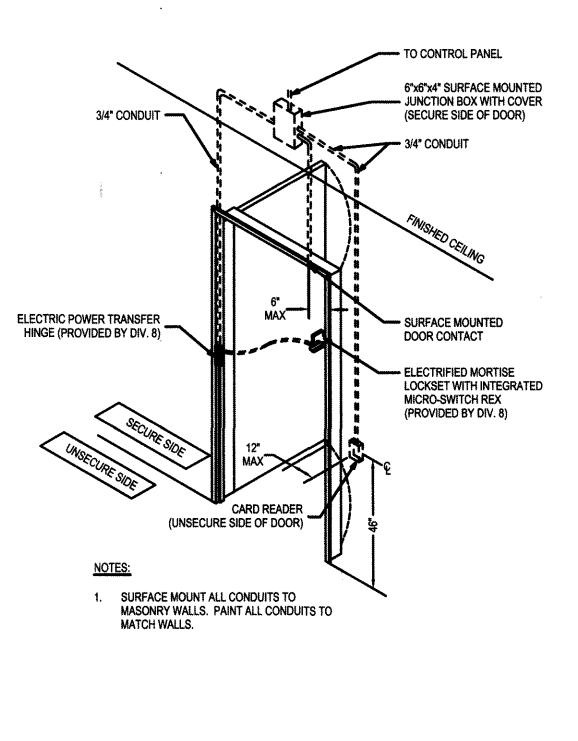

SINGLE ACS DOOR WITH MORTISE LOCKSET W/ INTEGRATED REX

NOT TO SCALE

ES.501

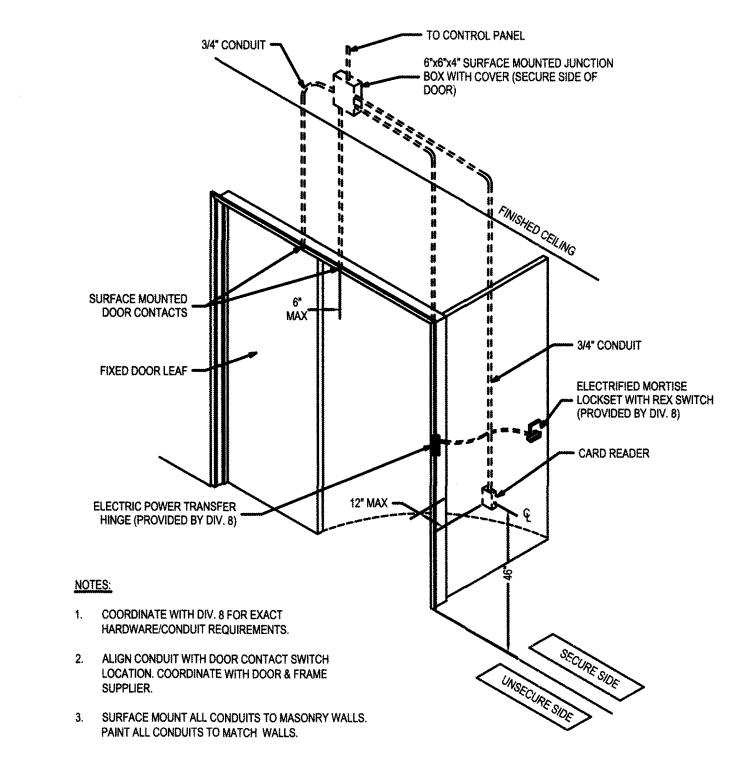

DOUBLE ACS DOOR WITH MORTISE LOCKSET AND A FIXED LEAF

NOT TO SCALE ES.501

图 Bid Set County Response Set Pricing/Permit Set 100% Design Development No. Date Description

SIMPSON GUMPERTZ & HEGER

Simpson Gumpertz & Heger Inc.

main: 202.239.4199 fax: 202.239.4198

1828 L Street NW, Suite 950

Washington, DC 20036

Door Hardware

Consultant

Consultant

Consultant

| Engineering of Structures | and Building Enclosures

7820 Carters Run Drive Marshall, VA 20115 540.351.0553

Chantilly, VA 20151 571.325.5000

703.560.2200

Forella Group, LLC. 9495 Silver King Ct., Suite A Fairfax, VA 22031

GHD, Inc. 14585 Avion Parkway, Suite 150


Chicago Los Angeles New York San Francisco Washington, DC

PHYSICAL EDUCATION BLDG **EXTERIOR RENOVATION** MONTGOMERY COLLEGE GERMANTOWN CAMPUS

20200 OBSERVATION DRIVE GERMANTOWN, MD 20876

DETAILS SECURITY

Project No. 150049.01	Checked DMS		Date 01/22/16
Drawn MSM	Approved DRM	d	Scale AS NOTED
MARYLAND KONTRESO		Drawing	No.

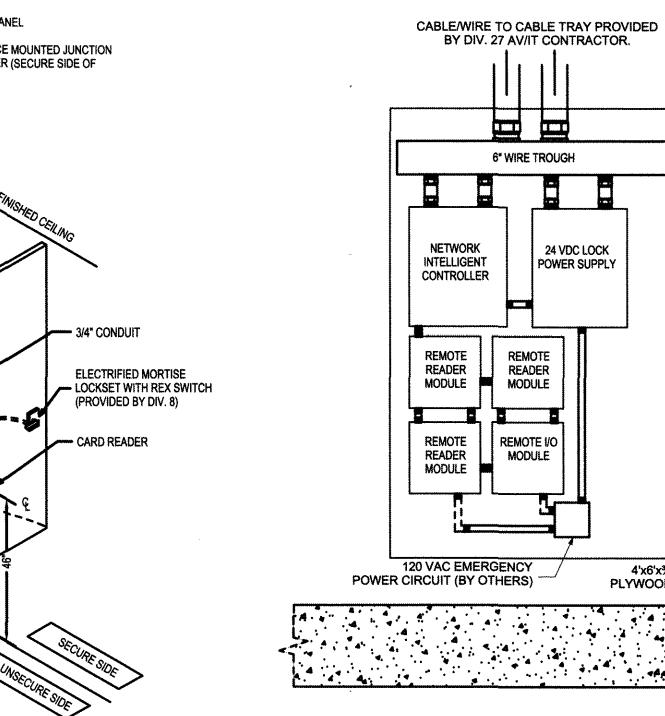

DOUBLE ACS DOOR WITH MORTISE LOCKSET W/ INTEGRATED REX

ELECTRIFIED MORTISE

ELECTRIC POWER TRANSFER HINGE (PROVIDED BY DIV. 8)

1. COORDINATE WITH DIV. 8 FOR EXACT HARDWARE/CONDUIT REQUIREMENTS.

2. ALIGN CONDUIT WITH DOOR CONTACT SWITCH

PAINT ALL CONDUITS TO MATCH WALLS.

LOCATION. COORDINATE WITH DOOR & FRAME

SURFACE MOUNT ALL CONDUITS TO MASONRY WALLS.

LOCKSET WITH REX_

SWITCH (PROVIDED BY DIV. 8)

ELEVATION PLAN - IT CLOSET NOT TO SCALE ES.501

4'x6'x¾" FIRE RATED PLYWOOD BACKBOARD

> Professional Certification: I hereby certify that these documents were prepared or approved by me, and that I am a duly licensed professional engineer under the laws of the State of Maryland, License No. 46280, Expiration Date: December 29, 2016